


BAGEL BEE



400 W. DAVIS, SUITE 110
CONROE, TX 77301

E/B/E Project Number : 26049.00

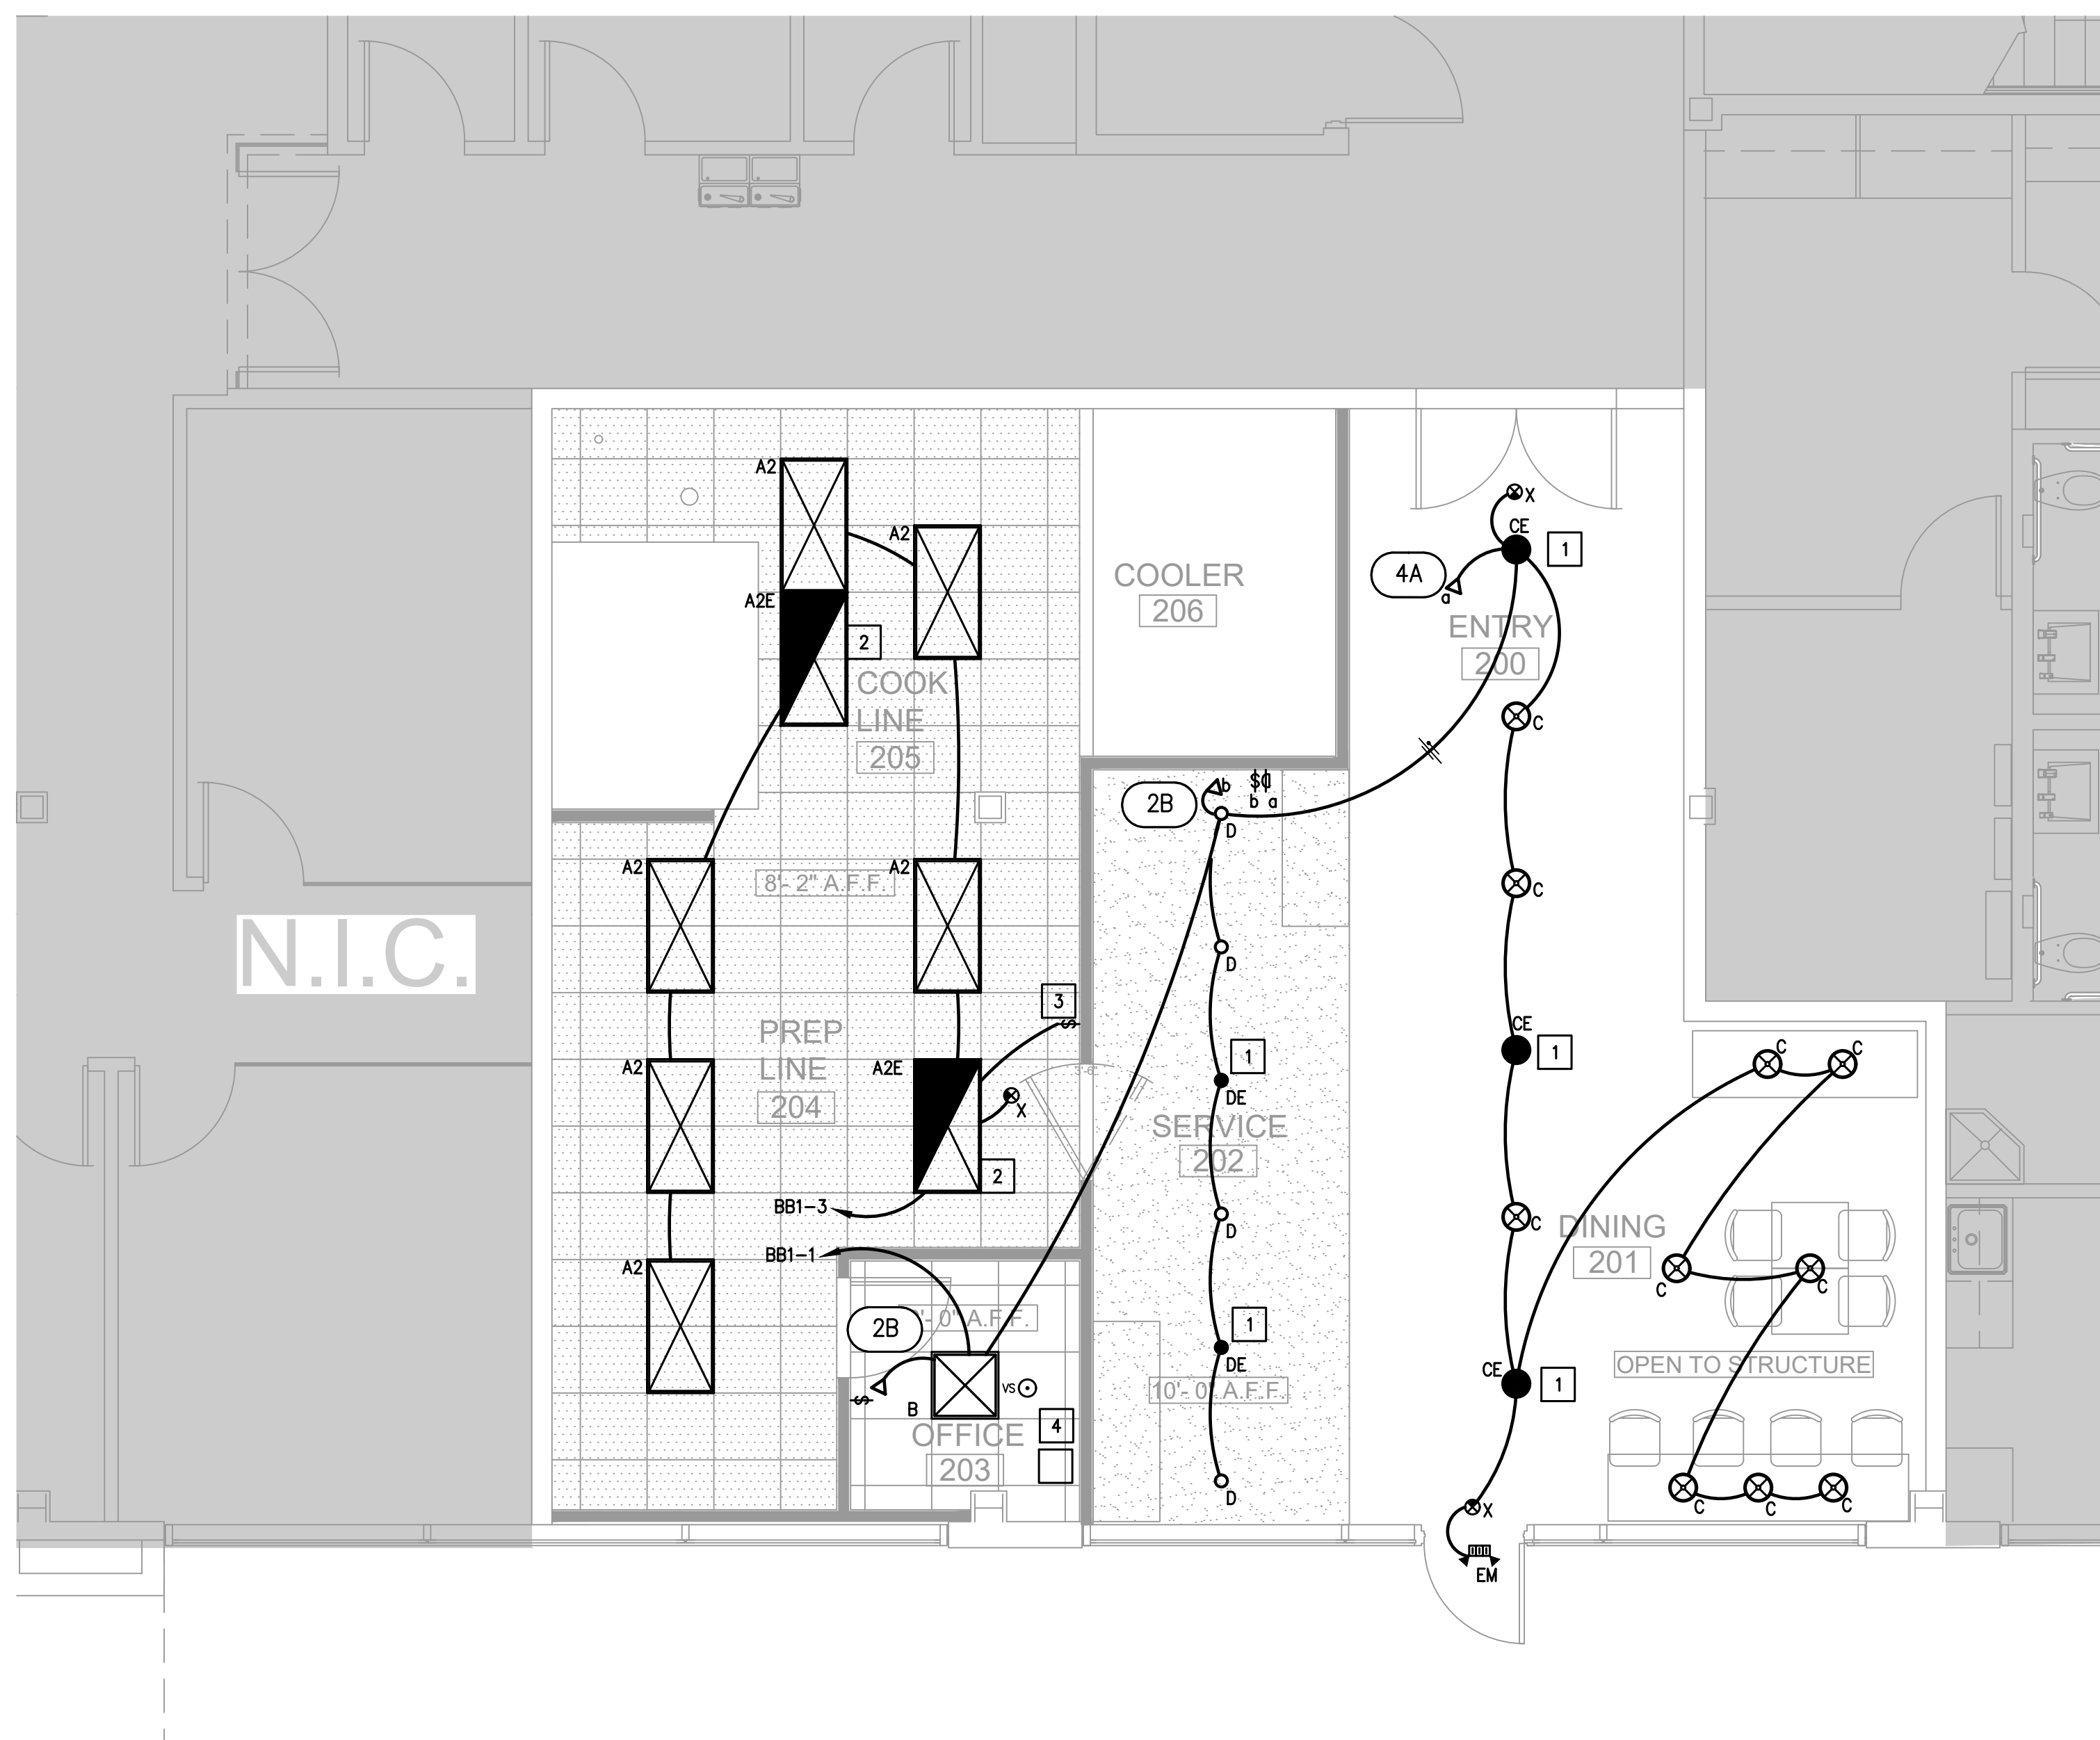

ELECTRICAL LIGHTING KEYED NOTES:

- 1 CROSS HATCHING INDICATES EMERGENCY LIGHTING. CONNECT TO FLOOR EMERGENCY LIGHTING CIRCUIT. VERIFY LOAD DOES NOT EXCEED 1900V.A. PER 20A., 120V. CIRCUIT. FIXTURE TO RUN CONTINUOUSLY AND UN-SWITCHED.
- 2 CROSS HATCHING INDICATES EMERGENCY LIGHTING. CONNECT TO FLOOR EMERGENCY LIGHTING CIRCUIT. VERIFY LOAD DOES NOT EXCEED 1900V.A. PER 20A., 120V. CIRCUIT. PROVIDE RELAY SO THAT FIXTURE IS SWITCHED UNDER NORMAL OPERATIONS.
- 3 PROVIDE ON/OFF TOGGLE SWITCH AT THIS LOCATION.
- 4 PROVIDE A 250VA, 90-MINUTE INVERTER FOR ALL EM LIGHT FIXTURES. REFER TO LIGHT FIXTURE SCHEDULE FOR ADDITIONAL INFORMATION. COORDINATE EXACT LOCATION ABOUT CEILING PRIOR TO COMMENCEMENT OF WORK.


ELECTRICAL LIGHTING CONTROL NOTES:

1. TIMECLOCK TO BE INTERMATIC ET2100 SERIES WITH TWO INDEPENDENT OUTPUTS AND HOLIDAY FUNCTION.
TIME CLOCK FEATURES:
A. 365-DAY PROGRAMMABLE CLOCK WITH 48 ON/OFF FEATURES.
B. AUTOMATIC DAYLIGHT SAVING TIME (DST) ON/OFF ADJUSTMENT.
C. NON-VOLATILE EEPROM MEMORY FOR LIFETIME PROGRAMMING PROTECTION.
D. TEMPORARY OVERRIDE OR PERMANENT MANUAL OVERRIDE AVAILABLE VIA CONTROL BUTTONS.
E. ADDITIONAL MODE OF OPERATION ALLOWS FOR ON/OFF BUTTONS TO BECOME A 2 HOUR OVERRIDE CONTROL.
F. 100-HOUR SUPERCAPACITOR ELIMINATES BATTERY DEPENDENCY.
G. 50 HOLIDAY BLOCKS WITH SCHEDULES.
2. CIRCUIT TO BE CONTROLLED BY TIMECLOCK OUTPUT
BB1-7 SIGN

ISSUED FOR CLIENT APPROVAL	DATE
ISSUED FOR BIDDING	05/08/2026
ISSUED FOR PERMIT	05/08/2026
ISSUED FOR CONSTRUCTION	

REVISIONS		
MARK	DESCRIPTION	DATE
	90% REVIEW SET	2026/04/07
	PERMIT AND BID SET	2026/05/08

The information, ideas, designs, details, layouts, techniques, features, arrangements, plans, sequences, dimensions, allowances, tolerances, conceptions, specifications, intentions, technology or embodiments, as illustrated, arranged, displayed, noted, recorded, indicated, represented, disclosed, evidenced, detailed or otherwise reduced to tangible form herein, either expressly, inherently or by implication, are the confidential and proprietary information of SLI Design, Inc., and shall not be used for any purpose other than the specific project or undertaking identified on the drawing title block or legend for which they are and have been prepared by SLI Design, Inc. Any other reproduction, disclosure or use of any portion of the confidential and proprietary information of SLI Design, Inc., shall be a breach of the obligation of confidence created by the acceptance of this drawing from SLI Design, Inc. for a specific project or Contract. Any copying, duplicating, reproducing, utilization, alteration, modification, revision or change to this drawing, is expressly prohibited unless done with the prior written consent or approval of SLI Design, Inc., and shall not be undertaken without receipt of such prior written approval. This drawing is loaned by SLI Design, Inc., for the limited purpose of complying with a specific Contract. The drawing remains the property of SLI Design, Inc., and shall be returned upon request or completion of the contract, unless specifically authorized by Contract, under which it was loaned.

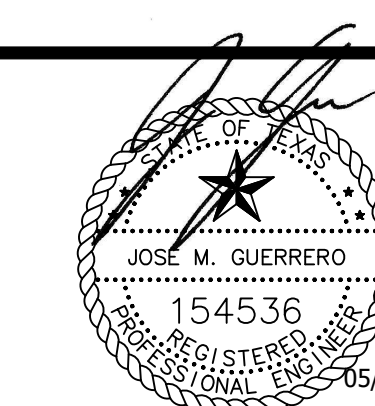

DRAWING TITLE
ELECTRICAL LIGHTING PLAN


SHEET NO.

E1.01

01 ELECTRICAL LIGHTING PLAN - LEVEL 01

SCALE: 1/4"=1'-0"

TRUE NORTH PLAN NORTH

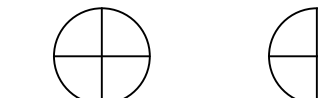

SCALE: 1/4"=1'-0"

EIB/E Mechanical
Electrical
Plumbing
CONSULTING ENGINEERS

12603 Southwest Frwy, Ste 170, Stafford, Tx 77477
Tel: (713) 840-0177 / Firm Reg. No: 5638

PM	MECH	ELEC	PLBG	CHCK
JG	THV	JG	BM	JG